


- 4. ANY DETAIL CRITICAL TO DESIGN $\,\%\%$ uMUST BE LOCATED BY A FIELD SURVEY.
- 5. ADOPT SPOT LEVELS IN PREFERENCE TO CONTOURS.
- ALL DETAIL AND FEATURES SHOWN HEREON HAVE BEEN PLOTTED IN RELATION
 TO THE OCCUPATIONS (FENCES AND/OR WALLS ETC), THESE OCCUPATIONS HAVE
 NOT YET BEEN ACCURATELY LOCATED IN RELATION TO THE BOUNDARIES.
- 7. ALL TREE DIMENSIONS ARE APPROXIMATE.

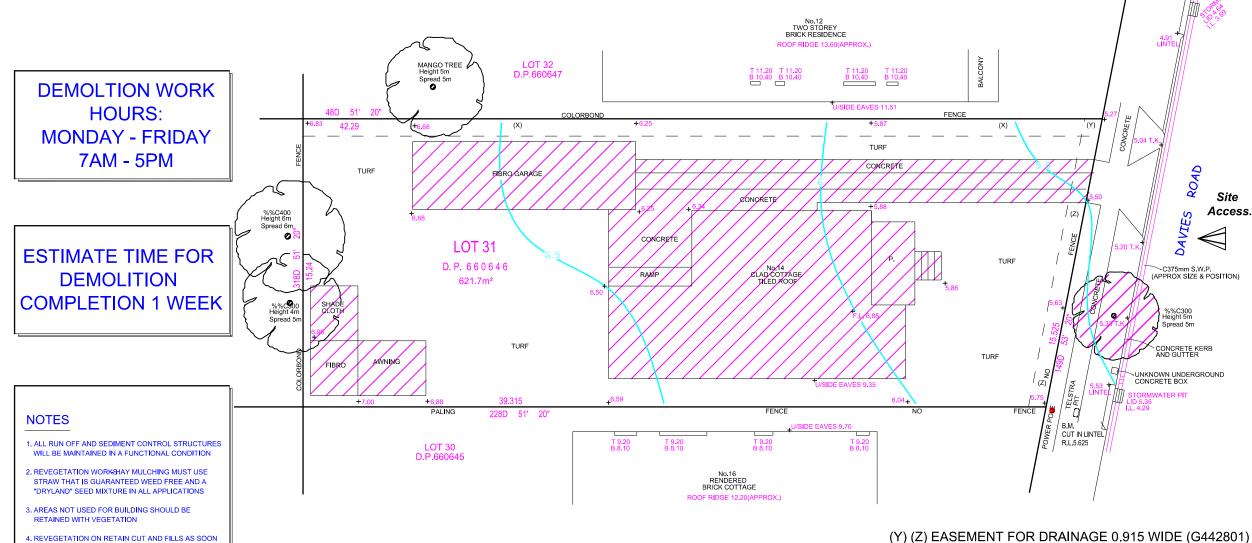

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AS POSSIBLE DURING CONSTRUCTION


(Y) (Z) EASEMENT FOR DRAINAGE 0.915 WIDE (G442801) (X) (Y) EASEMENT FOR DRAINAGE 0.915 WIDE (G442805)

CONTOUR INTERVAL - 0.5 METRES

DENOTES WINDOW

DENOTES TOP OF WINDOW

DENOTES BOTTOM OF WINDOW

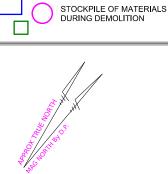



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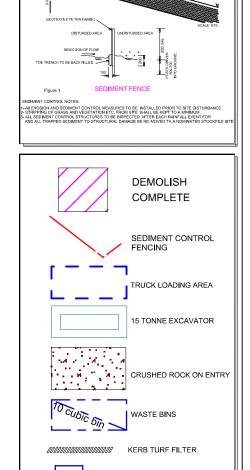
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Mr & Mrs Phillip Project Title: Dual Occupancy & Torrens Title Subdivision at: L31, 14 Davies Road, Padstow dp660646 Not FOR CONSTRUCTION 28/06/22 DA SUBMISSION Date


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LOT 31
Total Site Area = 621.70m2
Torrens Subdivision Plan



Client:		Not F	OR CONSTRUCTION
Mr & Mrs Phillip	Ε		
Project Title :	D		
Dual Occupancy & Torrens Title	С		
Subdivision at:	В		
L31, 14 Davies Road, Padstow dp660646	A No.	28/06/22 Date	DA SUBMISSION Revision

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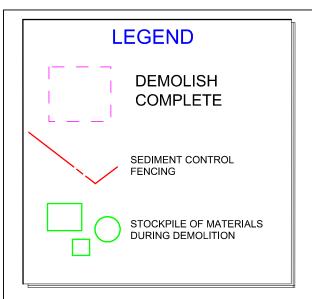
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TORRENS SUBDIVISION				
Scale: 1:100	Drawn By:	Drawing No.		
Date: 05/05/22	Issue:	01a		
00,00,22				

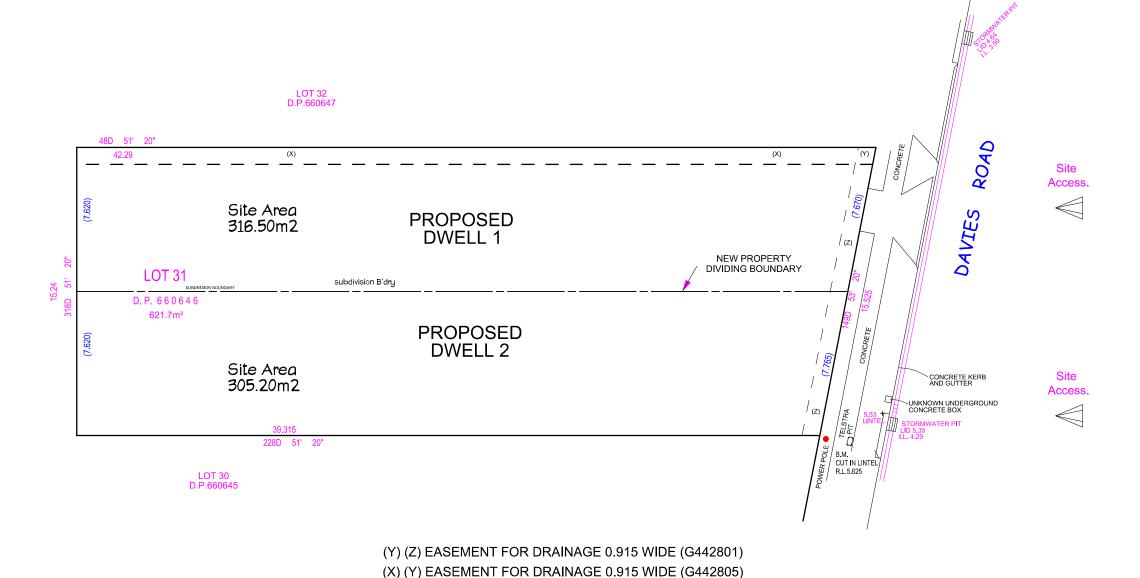

CALCULATIONS

Calculated Total Site Area: 621.70m2

FLOOR SPACE

310.85m2 / 50% FSR allowed:

Dwelling 1 / Site 316.50m2

GF: 85.300m2 FF: 72.125m2

Total FSR achieved:157.425m2 Dwelling 2 / Site 305.20m2

GF: 80.47m2 FF: 72.125m2

Total FSR achieved:152.595m2 (COMPLIES NUMERICALLY)

PRIVATE OPEN SPACE

: 92.70m2 Dwelling 1 : 87.20m2 Dwelling 2

CARPARKING

2 SPACES Dwelling 1 Dwelling 2 2 SPACES

LANDSCAPING 36.62% : 117.70m2 Dwelling 1 Dwelling 2 : 110.00m2

R/Water Tank

: 2000L Dwelling 1 Dwelling 2 : 2000L

Roof Areas

Dwelling 1 : 152.20m2 : 147.10m2 Dwelling 2

LOT 32 D.P.660647 ROAD (X) (X) ⁸ 21 ONCRETE TURF DAVIES PATIO L'scape L'scape %%C400 Height 6m Spread 6m Area: 92.7 P.O.S. **LOT 31** Ø. C375mm S.W.P. (APPROX SIZE & POSITION) D. P. 660646 L'scape D2 Area: 87.2 P.O.S. 621.7m² PATIO FFL RL 6.600 CONCRETE KERB AND GUTTER GARAGE FFL RL 5.980 L'scape B.M. CUT IN LINTEL R.L.5.625 T 9.20 B 8.10 LOT 30 D.P.660645 T 9.20 B 8.10 T 9.20 B 8.10 No.16 RENDERED BRICK COTTAGE

(Y) (Z) EASEMENT FOR DRAINAGE 0.915 WIDE (G442801)

(X) (Y) EASEMENT FOR DRAINAGE 0.915 WIDE (G442805)

CONTOUR INTERVAL - 0.5 METRES

DENOTES WINDOW

DENOTES TOP OF WINDOW

DENOTES BOTTOM OF WINDOW





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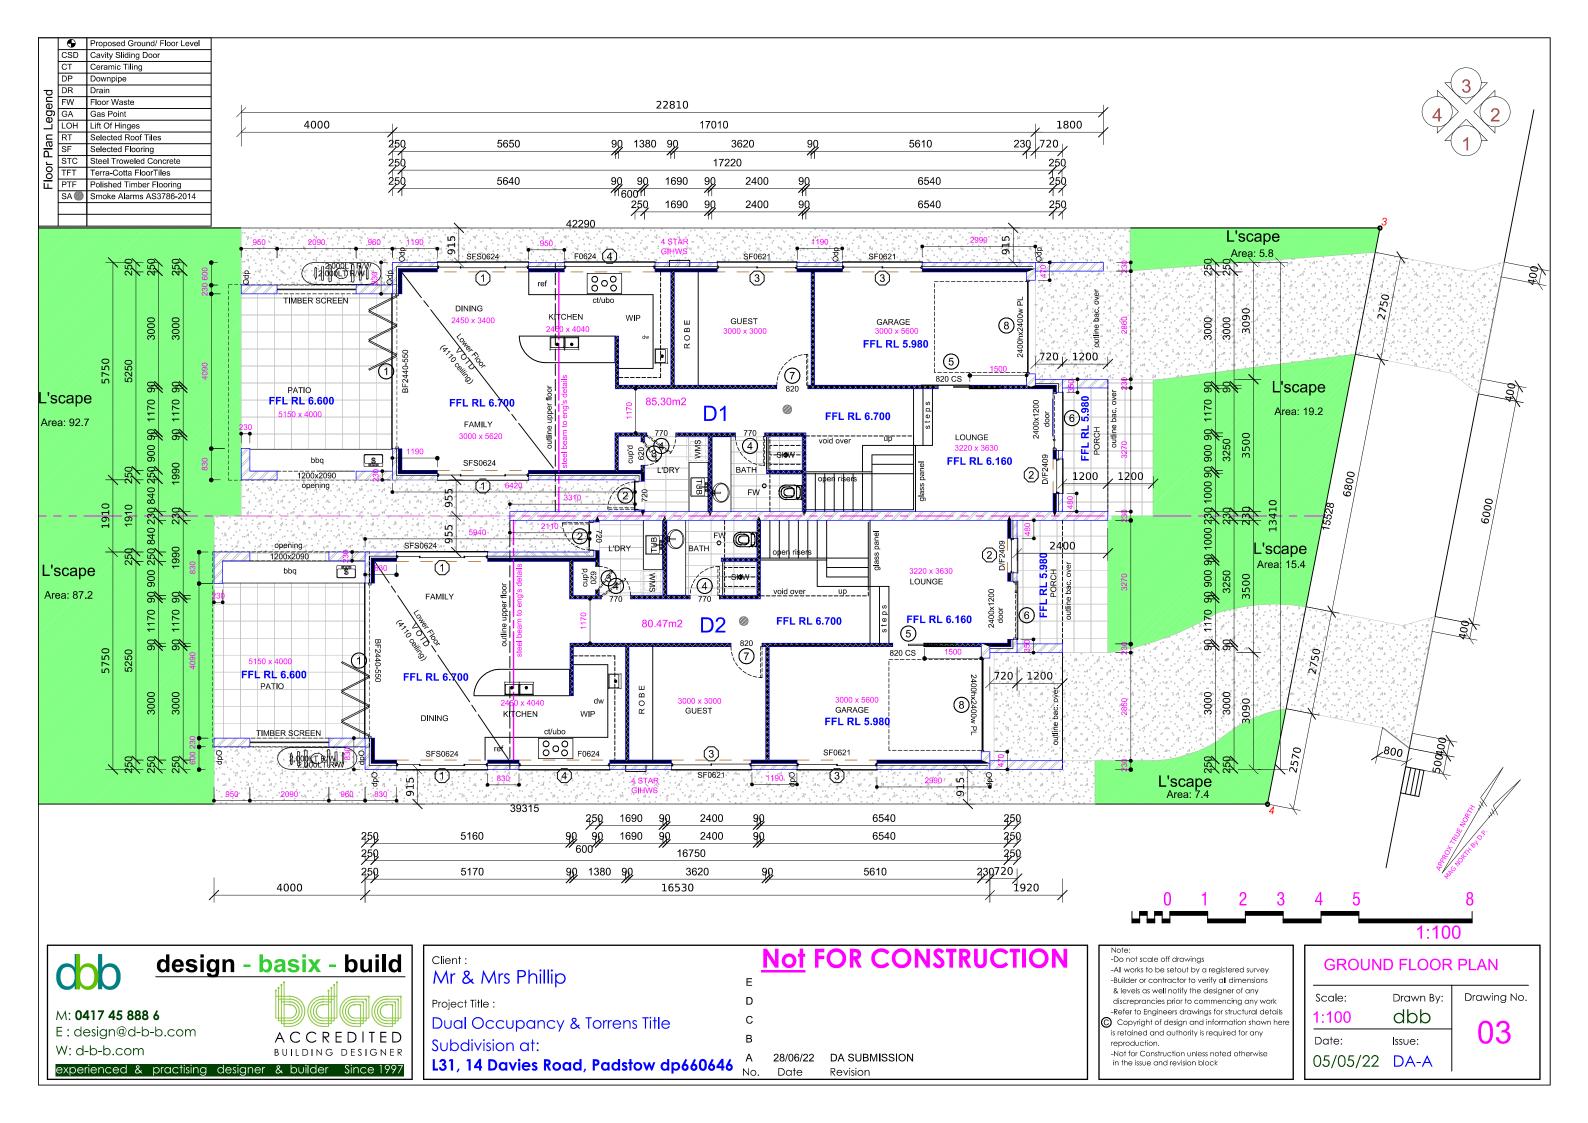



Client: Mr & Mrs Phillip Project Title: **Dual Occupancy & Torrens Title** Subdivision at: 28/06/22 DA SUBMISSION L31, 14 Davies Road, Padstow dp660646 Date Revision


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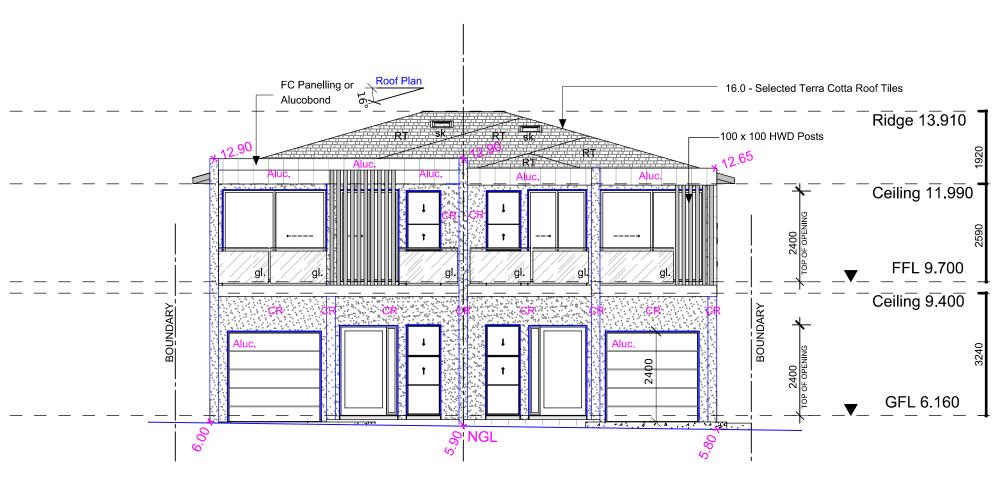
PROPOSED SITE PLAN				
Scale: Drawn By: Drawing No. 1:200 dbb				
Date: 05/05/22	Issue: DA-A	02		





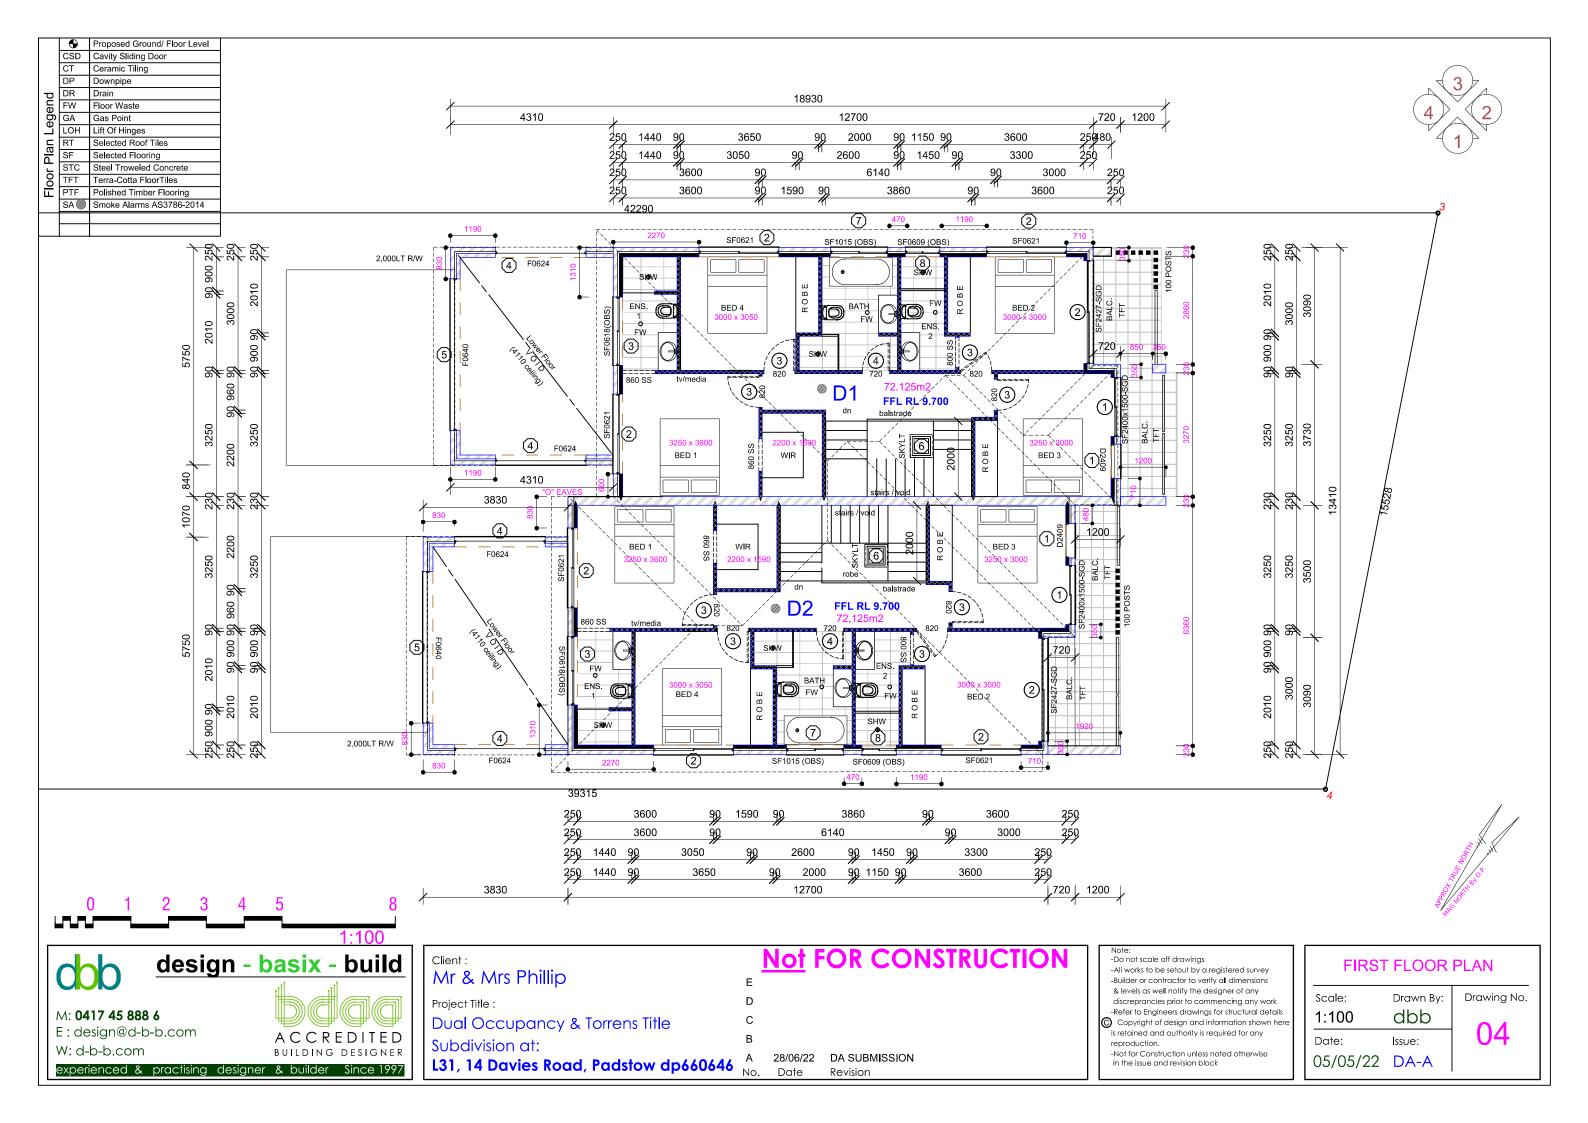


Colourbond Roofing Elevation Legend CR Rendered Brickwork DP Downpipe Fbr Face Brickwork Cement Render Obscure Glazing RT Roof Tiles Selected НХ Harditex cladding/rende FC Fibre Cement Cladding Aluc. Alucobond Panels

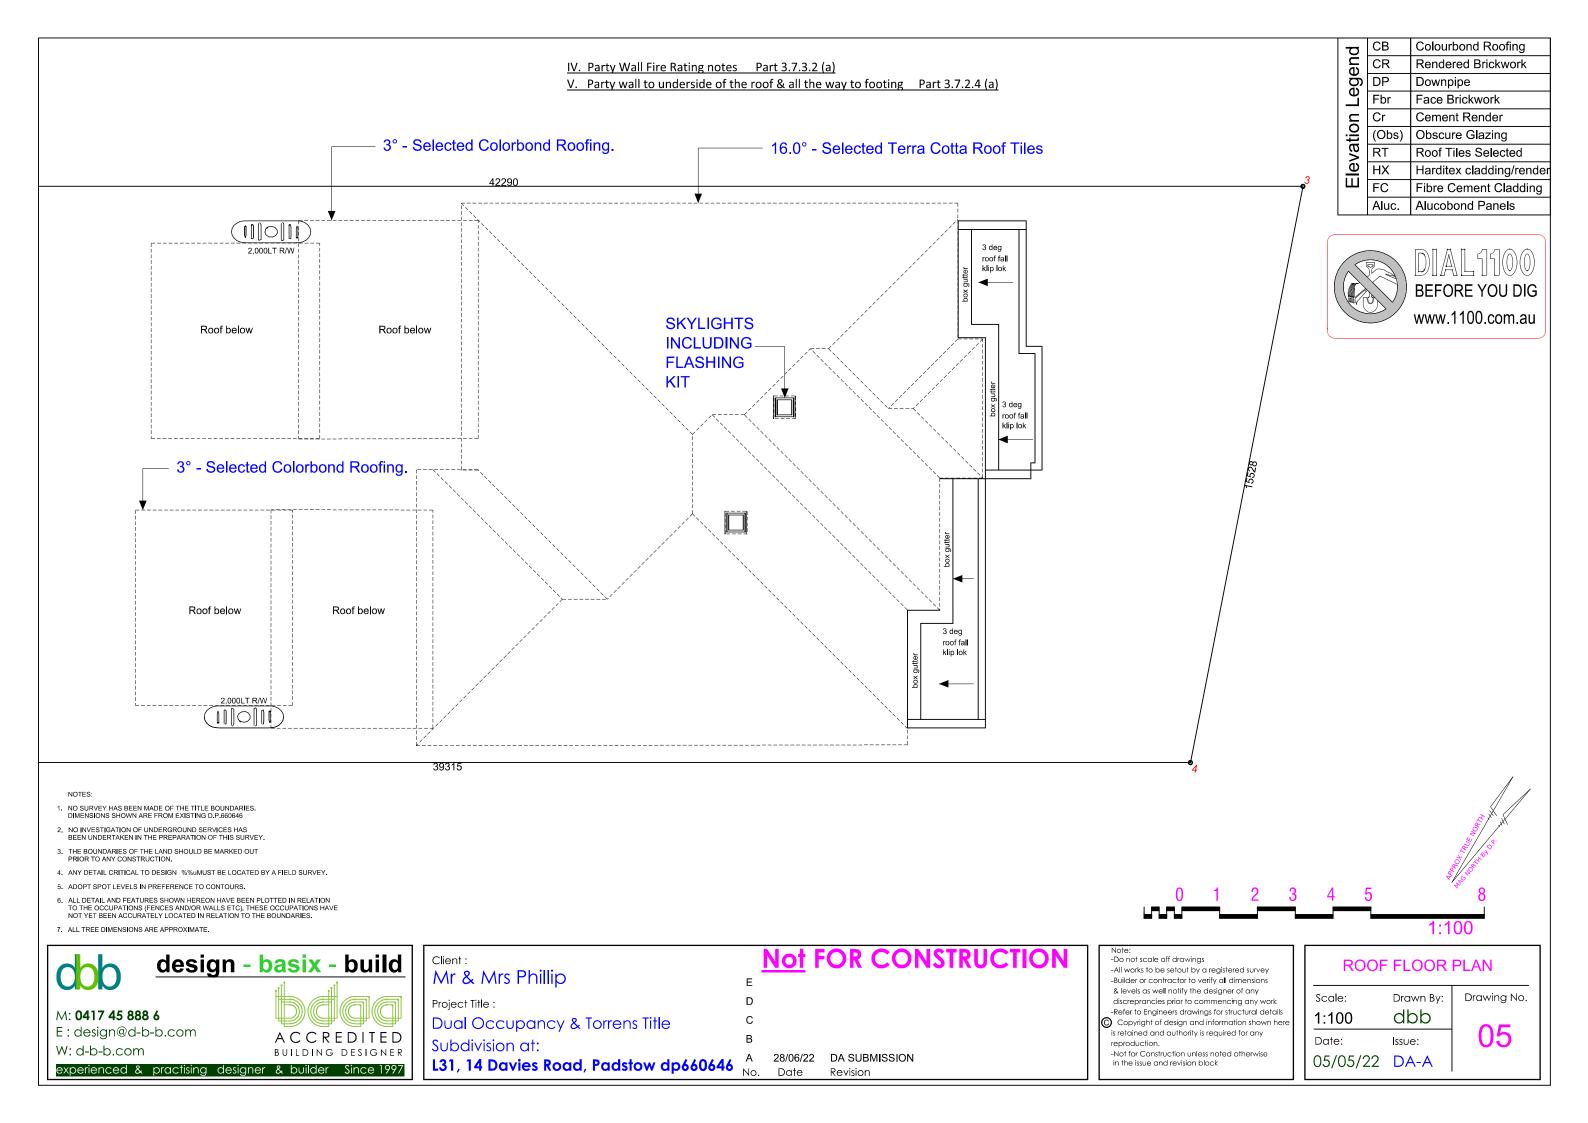

NORTH EAST ELEVATION FRONT ELEVATION

(TO DAVIES ROAD)

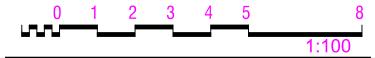





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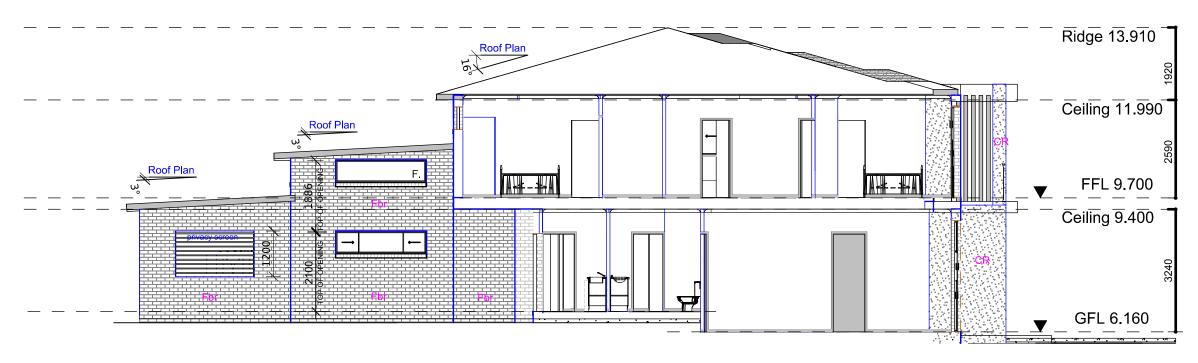
FRONT ELEVATION			
Scale:	Drawn By:	Drawing No.	
1:100	dbb		
Date:	Issue:	06	
05/05/22	DA-A		



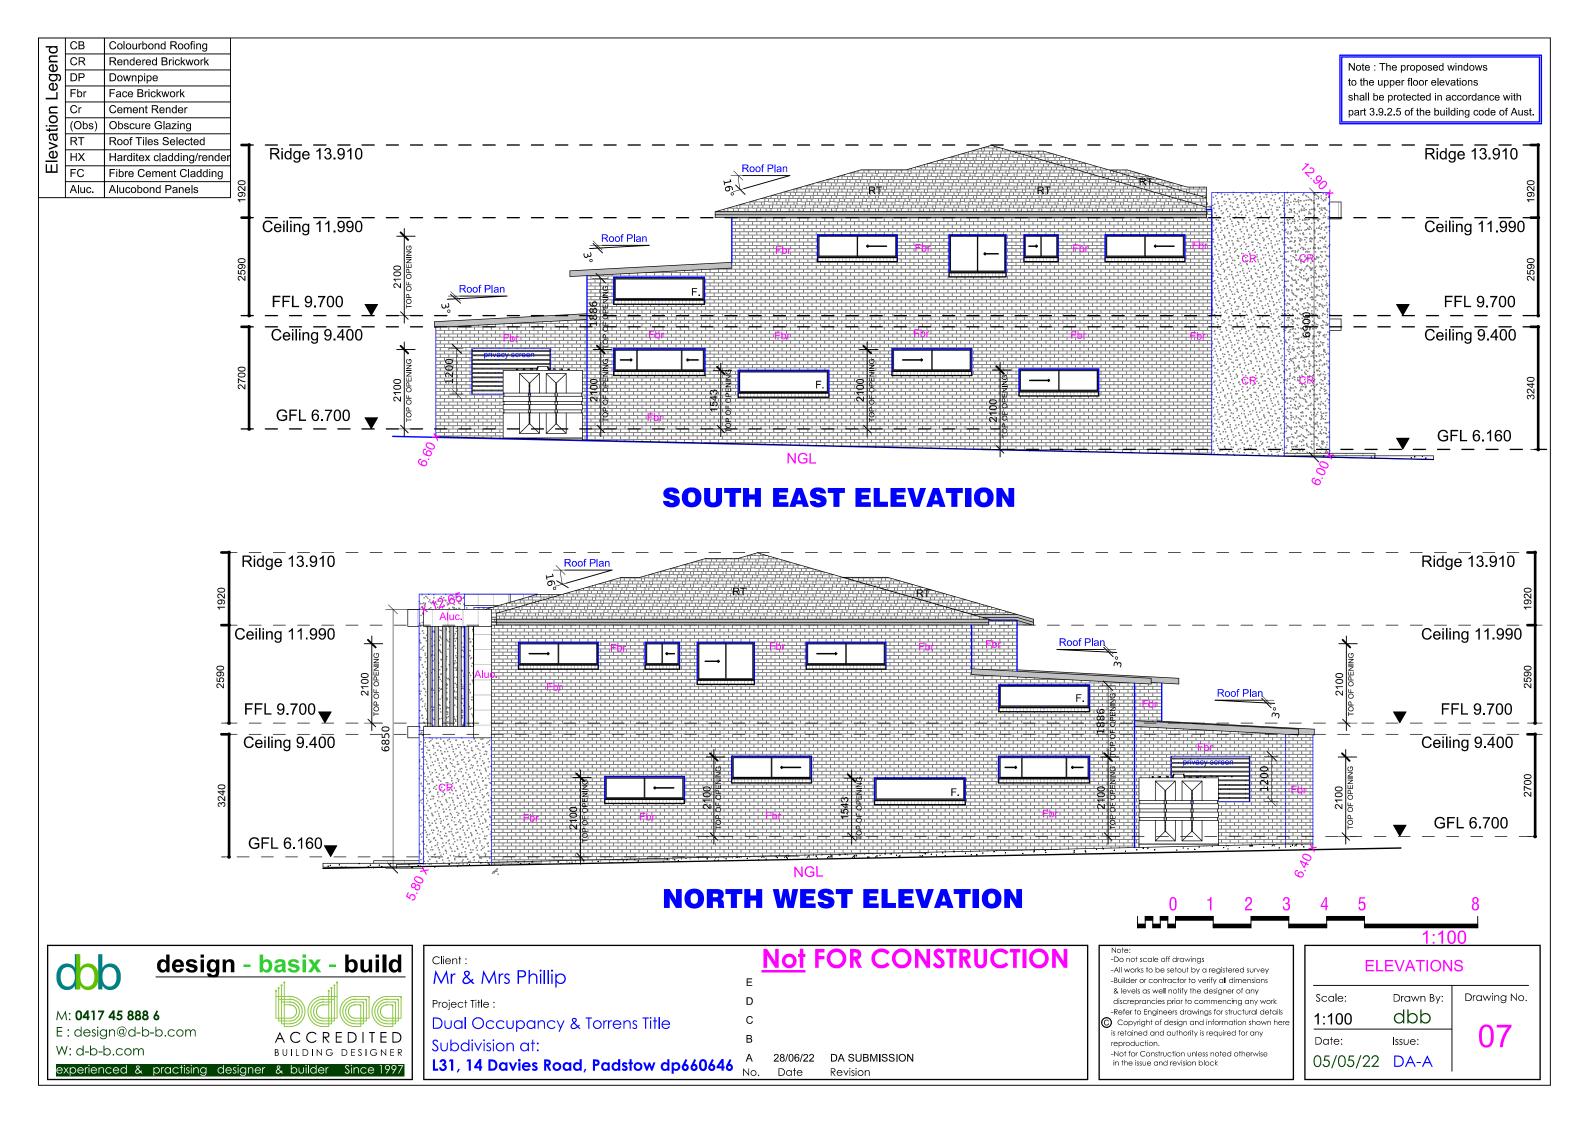

Colourbond Roofing Elevation Legend CR Rendered Brickwork DP Downpipe Fbr Face Brickwork Cement Render (Obs) Obscure Glazing RT Roof Tiles Selected НХ Harditex cladding/rende FC Fibre Cement Cladding Aluc. Alucobond Panels

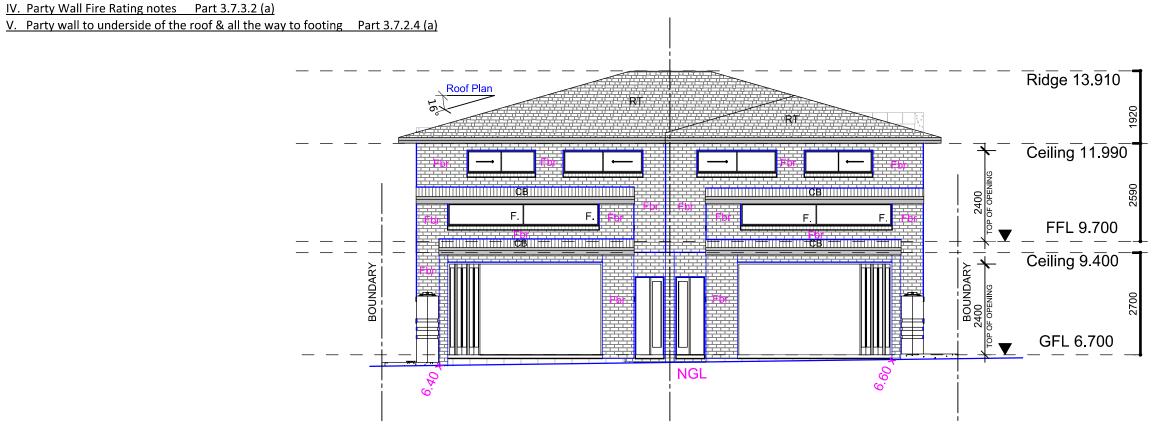SOUTH WEST ELEVATION



SECTION A - A



Client:
Mr & Mrs Phillip

Project Title:
Dual Occupancy & Torrens Title
Subdivision at:
L31, 14 Davies Road, Padstow dp660646

No. Date

Not FOR CONSTRUCTION

E

A 28/06/22 DA SUBMISSION
Revision


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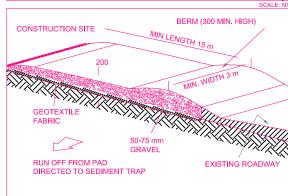
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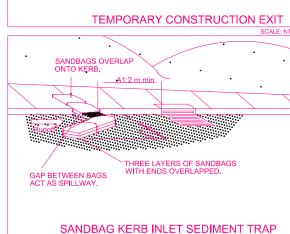
REAR ELEVATION /			
SECTION			
Scale:	Drawn By:	Drawing No.	
1:100	dbb	00	
Date:	Issue:	80	
05/05/22	DA-A		

WASTE MANAGEMENT NOTES

- * Selected structural timber, bricks and terra-cotta roof construction of proposed residence.
- * Disposal of demolition materials to waste disposal centre.





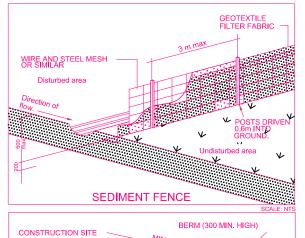

WARNING SOIL & WATER:


- * INSTALL SEDIMENT CONTROL FENCES ALONG THE LOW
- SIDE OF THE SITE <u>BEFORE</u> WORK BEGINS, * STABILISE A SINGLE ENTRY/EXIT POINT USING LARGE
- AGGREGATE. * MINIMISE DISTURBANCE OF VEGETATION DURING EXCAVATION. * PLACE SOIL STOCKPILES BEHIND SEDIMENT FENCING. * KEEP THE ROAD AND FOOTPATH CLEAN BY SWEEPING REGULARLY.

- WAS LE:


 **CONSTRUCT TWO (2) WASTE BAYS TO ASSIST SORTING AND RECYCLING OF WASTE.


 **ALL WASTE MUST BE CONTAINED IN WASTE BAYS.

 **REUSE AND RECYCLING OF WASTE SHOULD BE MAXIMISED.
- EROSION CONTROL:
- All disturbed areas shall be progressively stabilised and/or revegetated so that no areas remain exposed to potential erosion damage for a period of greater than 14 days.

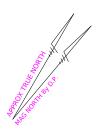



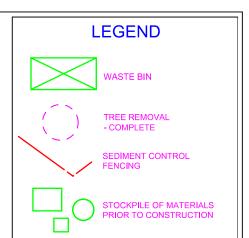

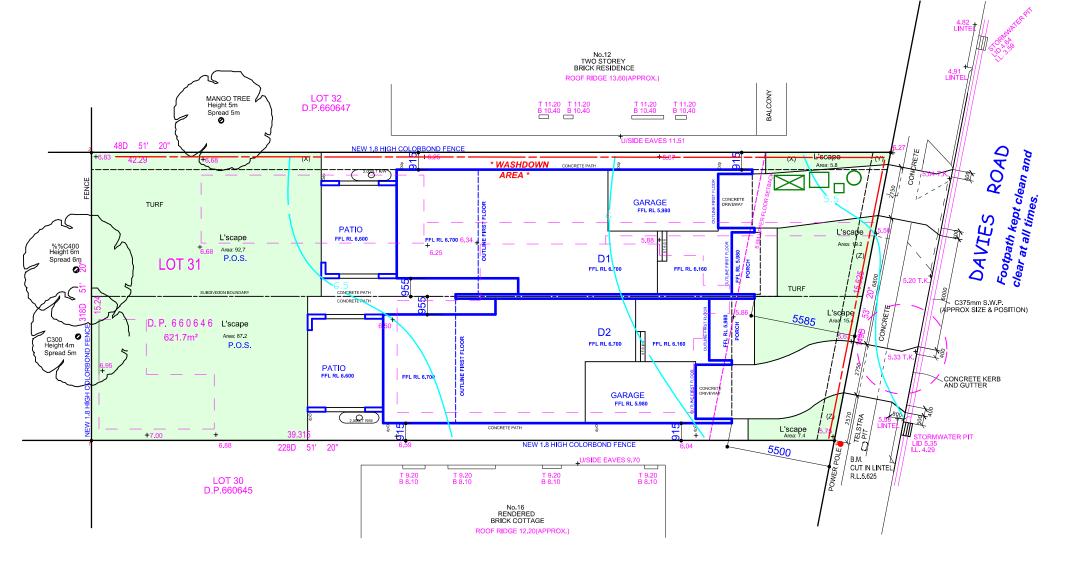



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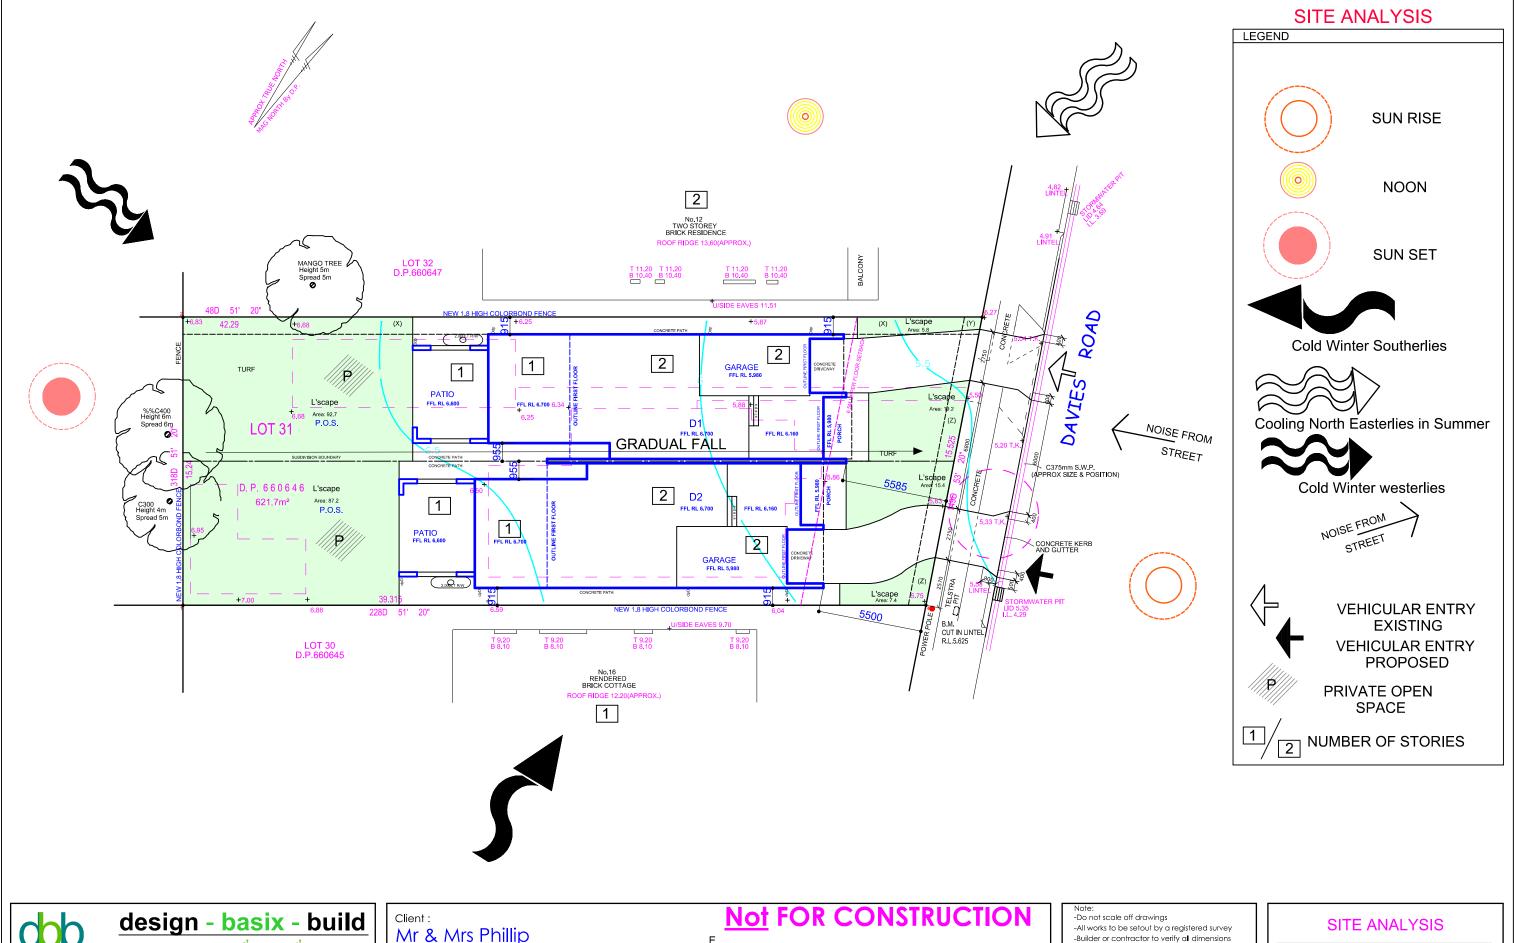
Mr & Mrs Phillip Project Title: **Dual Occupancy & Torrens Title**

Subdivision at: L31, 14 Davies Road, Padstow dp660646


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SOIL EROSION & WASTE MANAGMENT PLAN Drawing No. Scale: Drawn By: dbb 1:200 Date: Issue: 05/05/22 DA-A







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SITE ANALYSIS				
Scale: 1:200	Drawn By:	Drawing No.		
Date: 05/05/22	Issue: DA-A	10		

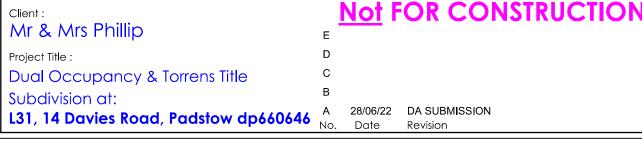Building Sustainability Index www.basix.nsw.gov.au

BASIX Certificate

Building Sustainability Index www.basix.nsw.gov.au

Single Dwelling 2

Certificate number: 1318373S

Water Commitments

Sinale Dwelling 1

Certificate number: 1313790S

Fixtures

The applicant must install showerheads with a minimum rating of 4 star (> 4.5 but <= 6 L/min plus spray force and/or coverage tests) in all showers in the development.

The applicant must install a toilet flushing system with a minimum rating of 3 star in each toilet in the development

The applicant must install taps with a minimum rating of 3 star in the kitchen in the development.

The applicant must install basin taps with a minimum rating of 3 star in each bathroom in the development.

Alternative water

Rainwater tank

The applicant must install a rainwater tank of at least 2000 litres on the site. This rainwater tank must meet, and be installed in accordance with, the requirements of all applicable regulatory authorities.

The applicant must configure the rainwater tank to collect rain runoff from at least 152.2 square metres of the roof area of the development (excluding the area of the roof which drains to any stormwater tank or private dam).

The applicant must connect the rainwater tank to:

all toilets in the development

at least one outdoor tap in the development (Note: NSW Health does not recommend that rainwater be used for human consumption in areas with potable water supply.)

Thermal Comfort Commitments

General features

The dwelling must not have more than 2 storeys.

The conditioned floor area of the dwelling must not exceed 300 square metres.

The dwelling must not contain open mezzanine area exceeding 25 square metres

The dwelling must not contain third level habitable attic room,

Floor, walls and ceiling/roof

The applicant must construct the floor(s), walls, and ceiling/roof of the dwelling in accordance with the specifications listed in the table below.

Construction	Additional insulation required (R-Value)	Other specifications
floor - concrete slab on ground, 91.6 square metres	nil	
floor - above habitable rooms or mezzanine, 24.78 square metres, framed	nil	
floor - suspended floor above garage, framed	nil	
external wall - brick veneer	2.86 (or 3.40 including construction)	
internal wall shared with garage - plasterboard	nil	
ceiling and roof - flat ceiling / pitched roof	ceiling: 4.5 (up), roof: foil/sarking	unventilated; medium (solar absorptance 0.475-0.70)

Note • Insulation specified in this Certificate must be installed in accordance with Part 3.12.1.1 of the Building Code of Australia.

Note • In some climate zones, insulation should be installed with due consideration of condensation and associated interaction with adjoining building materials

Thermal Comfort Commitments

Windows, glazed doors and skylights

The applicant must install the windows, glazed doors and shading devices described in the table below, in accordance with the specifications listed in the table. Relevant overshadowing specifications must be satisfied for each window and glazed door.

The dwelling may have 1 skylight (<0.7 square metres) which is not listed in the table

The following requirements must also be satisfied in relation to each window and glazed door:

- For the following glass and frame types, the certifier check can be performed by visual inspection.
- Aluminium single clear
- Aluminium double (air) cle

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- Timber/uPVC/fibreglass single clear - Timber/uPVC/fibreglass double (air) clear
- For other glass or frame types, each window and glazed door must be accompanied with certification showing a U value no greater
 than that listed and a Solar Heat Gain Coefficient (SHGC) within the range of those listed. Total system U values and SHGC must
 be calculated in accordance with National Fenestration Rating Council (NFRC) conditions. Frame and glass types shown in the
 table below or for reference only. table below are for reference only.
- Overshadowing buildings/vegetation must be of the height and distance from the centre and the base of the window and glazed door, as specified in the 'overshadowing' column.

The applicant must install the skylights described in the table below, in accordance with the specifications listed in the table, Total skylight area must not exceed 3 square metres (the 3 square metre limit does not include the optional additional skylight of less than 0.7 square metres that does not have to be listed in the table).

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ACCREDITED

W02 Bed W05 Void Ovr Far North-West facing W04 Kitchen

Skylight no.

Window/glazed door no.

North-East facing Vindow/glazed door no.

Door1 Bed 3

Door2 Bed 2

South-East facing

South-West facing

W04 Void ovr Fam

D1 Door Din/Fam. W03 Ensuite

W03 Garage

W02 Bed 4

Window/glazed

W07 Bath

W08 Ensuite

W02 Bed 2

W04 Void ovr E

Energy Commitments

The applicant must install the following hot water system in the development, or a system with a higher energy rating: gas instantaneous with a performance of 4 stars.

The applicant must install the following cooling system, or a system with a higher energy rating, in at least 1 living area: 1-phase

The applicant must install the following cooling system, or a system with a higher energy rating, in at least 1 bedroom: 1-phase

The applicant must install the following heating system, or a system with a higher energy rating, in at least 1 living area: 1-phase airconditioning; Energy rating: 7 star (average zone)

The applicant must install the following heating system, or a system with a higher energy rating, in at least 1 bedroom: 1-phase airconditioning; Energy rating; 7 star (average zone)

The applicant must ensure that the "primary type of artificial lighting" is fluorescent or light emitting diode (LED) lighting in each of the following rooms, and where the word "dedicated" appears, the fittings for those lights must only be capable of accepting fluorescent or light emitting isided (LED) lamps:

Shading device

Shading Device (Dimension within

Shading Device (Dimension within olid overhang 1200 mm, 810 mm bove head of window or glazed

verandah 1200 mm, 2495 mm above base of window or glazed door

eave 580 mm, 343 mm above head of window or glazed door

eave 580 mm, 343 mm above head of window or glazed door

eave 580 mm, 343 mm above l of window or glazed door

verandah 4000 mm, 2640 mm above not overshadowed

2-4 m high, 2 m awa

2-4 m high, 2 m awa

2-4 m high, 2 m away

2-4 m high, 2-5 m away

The cooling system must provide for day/night zoning between living areas and bedrooms.

The heating system must provide for day/night zoning between living areas and bedrooms

Kitchen: individual fan, ducted to façade or roof; Operation control: manual switch on/off

At least 1 Bathroom; individual fan, ducted to facade or roof; Operation control; manual switch on/off

The applicant must install the following exhaust systems in the development:

Laundry: natural ventilation only, or no laundry; Operation control: n/a

at least 5 of the bedrooms / study; dedicated

Hot water

Cooling system

Heating system

Ventilation

Artificial lighting

airconditioning; Energy rating: 7 star (average zone

airconditioning; Energy rating: 7 star (average zone

	600	2410	aluminium, single, clear	none	2-4 m high, 2 m away
	600	2110	aluminium, single, clear	none	2-4 m high, 2 m away
	600	2110	aluminium, single, clear	none	2-4 m high, 2 m away
Din	600	2410	aluminium, single, clear	none	2-4 m high, 2-5 m away
	600	2110	aluminium, single, clear	eave 580 mm, 343 mm above head of window or glazed door	2-4 m high, 2-5 m away
d door no.	Maximum height (mm)	Maximum width (mm)	Туре	Shading Device (Dimension within 10%)	Overshadowing
d door no.			Type U-value: 6.6, SHGC: 0.441 - 0.539 (aluminium, single, tint)		Overshadowing 2-4 m high, 2-5 m away
d door no.	height (mm)	(mm)	U-value: 6.6, SHGC: 0.441 - 0.539	10%) eave 580 mm, 343 mm above head	

inium, single, clea

luminium, single, clea

aluminium, single, clea

aluminium, single, clea

uminium, single, clea

aluminium, single, clear

U-value: 6.6, SHGC: 0.441 - 0.539

2410

Client: Mr & Mrs Phillip
Project Title:
Dual Occupancy & Torrens Title
Subdivision at:

eave 580 mm, 343 mm above of window or glazed door

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Thermal Comfort Commitments

Windows, glazed doors and skylights

The applicant must install the windows, glazed doors and shading devices described in the table below, in accordance with the specifications listed in the table. Relevant overshadowing specifications must be satisfied for each window and glazed door.

The dwelling may have 1 skylight (<0.7 square metres) which is not listed in the table.

The following requirements must also be satisfied in relation to each window and glazed door

For the following glass and frame types, the certifier check can be performed by visual inspection

- Aluminium single clear
- Aluminium double (air) clear
- Timber/uPVC/fibreglass single clear
- Timber/uPVC/fibreglass double (air) clear

For other glass or frame types, each window and glazed door must be accompanied with certification showing a U value no greater than that listed and a Solar Heat Gain Coefficient (SHGC) within the range of those listed. Total system U values and SHGC must be calculated in accordance with National Fenestration Rating Council (NFRC) conditions. Frame and glass types shown in the table below are for reference only.

Overshadowing buildings/vegetation must be of the height and distance from the centre and the base of the window and glazed door, as specified in the 'overshadowing' column.

The applicant must install the skylights described in the table below, in accordance with the specifications listed in the table. Total skylight area must not exceed 3 square metres (the 3 square metre limit does not include the optional additional skylight of less than 0.7 square metres that does not have to be listed in the table).

Energy Commitments

at least 2 of the living / dining rooms; dedicated

the kitchen: dedicated

all bathrooms/toilets; dedicated

the laundry; dedicated

all hallways: dedicate

Natural lighting

The applicant must install a window and/or skylight in the kitchen of the dwelling for natural lighting.

The applicant must install a window and/or skylight in 2 bathroom(s)/toilet(s) in the development for natural lighting

The applicant must install a gas cooktop & electric oven in the kitchen of the dwelling.

Skylight no.	Maximum area (square metres)	Туре	Shading device
S01	0.36	timber, double clear/air fill	no shading

North Foot footon	height (mm)	(mm)		10%)	
North-East facing					1
Window/glazed door no.	Maximum height (mm)	Maximum width (mm)	Туре	Shading Device (Dimension within 10%)	Overshadowing
Door2 Bed 2	2400	2700	aluminium, single, clear	verandah 1920 mm, 2495 mm above base of window or glazed door	not overshadowed
Door1 Bed 3	2400	1500	aluminium, single, clear	verandah 1200 mm, 2495 mm above base of window or glazed door	not overshadowed
W02 Lounge	2400	910	aluminium, single, clear	solid overhang 1200 mm, 810 mm above head of window or glazed door	not overshadowed
W01 Bed 3	2400	910	aluminium, single, clear	verandah 1200 mm, 1745 mm above base of window or glazed door	not overshadowed
South-East facing					
W02 Bed 2	600	2110	aluminium, single, clear	eave 580 mm, 343 mm above head of window or glazed door	not overshadowed
W08 Ensuite	600	910	U-value: 6.6, SHGC: 0.441 - 0.539 (aluminium, single, tint)	eave 580 mm, 343 mm above head of window or glazed door	not overshadowed
W04 Kitchen	600	2410	aluminium, single, clear	none	2-4 m high, 2-5 m away
W07 Bath	1000	1510	U-value: 6.6, SHGC: 0.441 - 0.539 (aluminium, single, tint)	eave 580 mm, 343 mm above head of window or glazed door	not overshadowed
W01 Dining	600	2410	aluminium, single, clear	none	2-4 m high, 2-5 m away
W03 Guest	600	2110	aluminium, single, clear	none	2-4 m high, 2-5 m away
W02 Bed 4	600	2110	aluminium, single, clear	eave 580 mm, 343 mm above head of window or glazed door	not overshadowed
W03 Garage	600	2110	aluminium, single, clear	none	2-4 m high, 2-5 m away
W04 Void ovr Din	600	2410	aluminium, single, clear	none	2-4 m high, 2 m away
South-West facing					
D1 Door Din/Fam.	2400	4000	aluminium, single, clear	verandah 4000 mm, 2640 mm above base of window or glazed door	not overshadowed
W02 Bed 1	600	2110	aluminium, single, clear	eave 580 mm, 343 mm above head of window or glazed door	not overshadowed
W05 Void Ovr Fam	600	4010	aluminium, single, clear	eave 580 mm, 343 mm above head of window or glazed door	not overshadowed
Window/glazed door no.	Maximum height (mm)	Maximum width (mm)	Туре	Shading Device (Dimension within 10%)	Overshadowing
W03 Ensuite	600	1810	U-value: 6.6, SHGC: 0.441 - 0.539 (aluminium, single, tint)	eave 580 mm, 343 mm above head of window or glazed door	not overshadowed
North-West facing					
W04 Void ovr Fam	600	2410	aluminium, single, clear	none	2-4 m high, 2-5 m away
W01 Family	600	2410	aluminium, single, clear	none	2-4 m high, 2 m away

NERGY EFFICIENCY NOTE & GENERAL NOTES Drawing No. Scale: Drawn By: NTS dbb en.eff1 Date: Issue: 05/05/22 DA-A

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28/06/22 DA SUBMISSION Date Revision

Window Schedule							
Window Schedule	Height	Width	Mark	Description	Glass Area	Count	
	600	2410	1	600 X 2410 mm Sliding Windows	1.2	4	
Į t	2400	910	2	2400 X 910 mm Hung/Fixed Windows	1.8	2	
	600	2110	3	600 X 2110 mm Sliding Windows	1.0	4	
	600	2400	4	600 X 2410 mm Fixed Windows	1.2	2	

Door Schedule								
Door Schedule Mark Heigh Width		Width	Description	Count				
	1	2400	4000	2400 mm X 4000 mm Bi-Fold Doors.	2			
	2	2040	720	90 x 2040 x 720mm Passage Set - Prehung - Internal Door	2			
	3	2040	620	90 x 2040 x 620mm Passage Set - Prehung - Internal Door	2			
	4	2040	770	90 x 2040 x 770mm Passage Set - Prehung - Internal Door				
<u>-</u>	5	2040	820	90 x 2040 x 820mm Cavity Slider				
	6	2340	1200	90 x 2400 x 1200mm - Hinged - Entrance Door + 300 S'light				
	7	2040	820	90 x 2040 x 820mm Passage Set - Prehung - Internal Door				
	8	2440	2400	2440 x 2400 Panel Lift Door (2740)	2			
ot FOR CONSTI	RU	CT	IO	Note: -Do not scale off drawings -All works to be set out by a registered survey	ND			



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Client: Mr & Mrs Phillip Project Title : Dual Occupancy & Torrens Title Subdivision at: L31, 14 Davies Road, Padstow dp660646 A

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28/06/22 DA SUBMISSION

Revision

Date

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GROUND FLOOR PLAN WINDOWS & DOORS Drawing No.

Scale: Drawn By: dbb Date:

Issue: 05/05/22 DA-A

Window Schedule							
Window Schedule	Height	Width	Mark	Description	Glass Area	Count	
1	2400	910	1	2400 X 910 mm Hung Windows	1.8	2	
	600	2110	2	600 X 2110 mm Sliding Windows	1.0	6	
	600	1810	3	600 X 1810 mm Sliding Windows (OBS)	0.9	2	
	600	2400	4	600 X 2400 mm Fixed Windows	1.2	4	
	600	4010	5	600 X 4010 mm Fixed Windows	2.0	2	
	600	600	6	600 mm X 600 mm Fixed Skylights	0.2	2	
	1000	1510	7	1000 X 1510 mm Sliding Windows (OBS)	1.3	2	
=	600	910	8	600 X 910 mm Sliding Windows (OBS)	0.4	2	

Door Schedule						
Door Schedule	Mark	Height	Width	Description	Count	
	1	2400	1510	2400 mm X 1510 mm Sliding Glass Door.	2	
<u></u>	2	2400	2670	2400 mm X 2670 mm Sliding Glass Door,	2	
	3	2040	820	90 x 2040 x 820mm Passage Set - Prehung - Internal Door	8	
	4	2040	720	90 x 2040 x 720mm Passage Set - Prehung - Internal Door	2	



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Project Title :

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Scale: Drawn By: 1:100 dbb

Issue: Date: 05/05/22 DA-A Drawing No.

Colour board

design-basix-build

Project: 14 Davies Road PADSTOW Project No: DA-A

Applicant: dbb (design-basix-build) Ref: Colours-

Refer to 3d Visuals

Garage door White / Black Monument Frame & Acylic Panels



Dulux Monument

Common Walls Timeless Grey









Upper Floor Balcony Soffit and
Surround / Ref 3d Visual
ALUCOBOND® anodized look Satin brown

Exterior Face Brick / Austral Metallix - Blackstone





Roof Tiles Sambucca or featured Tiles Similar

Roof metal – Shale Grey or Similar Klip Lock / Refer to Roof Plan





Aluminium Windows Monument or Similar

Fascia (Monument) Gutter (Monument)



